

n Engineering Inc

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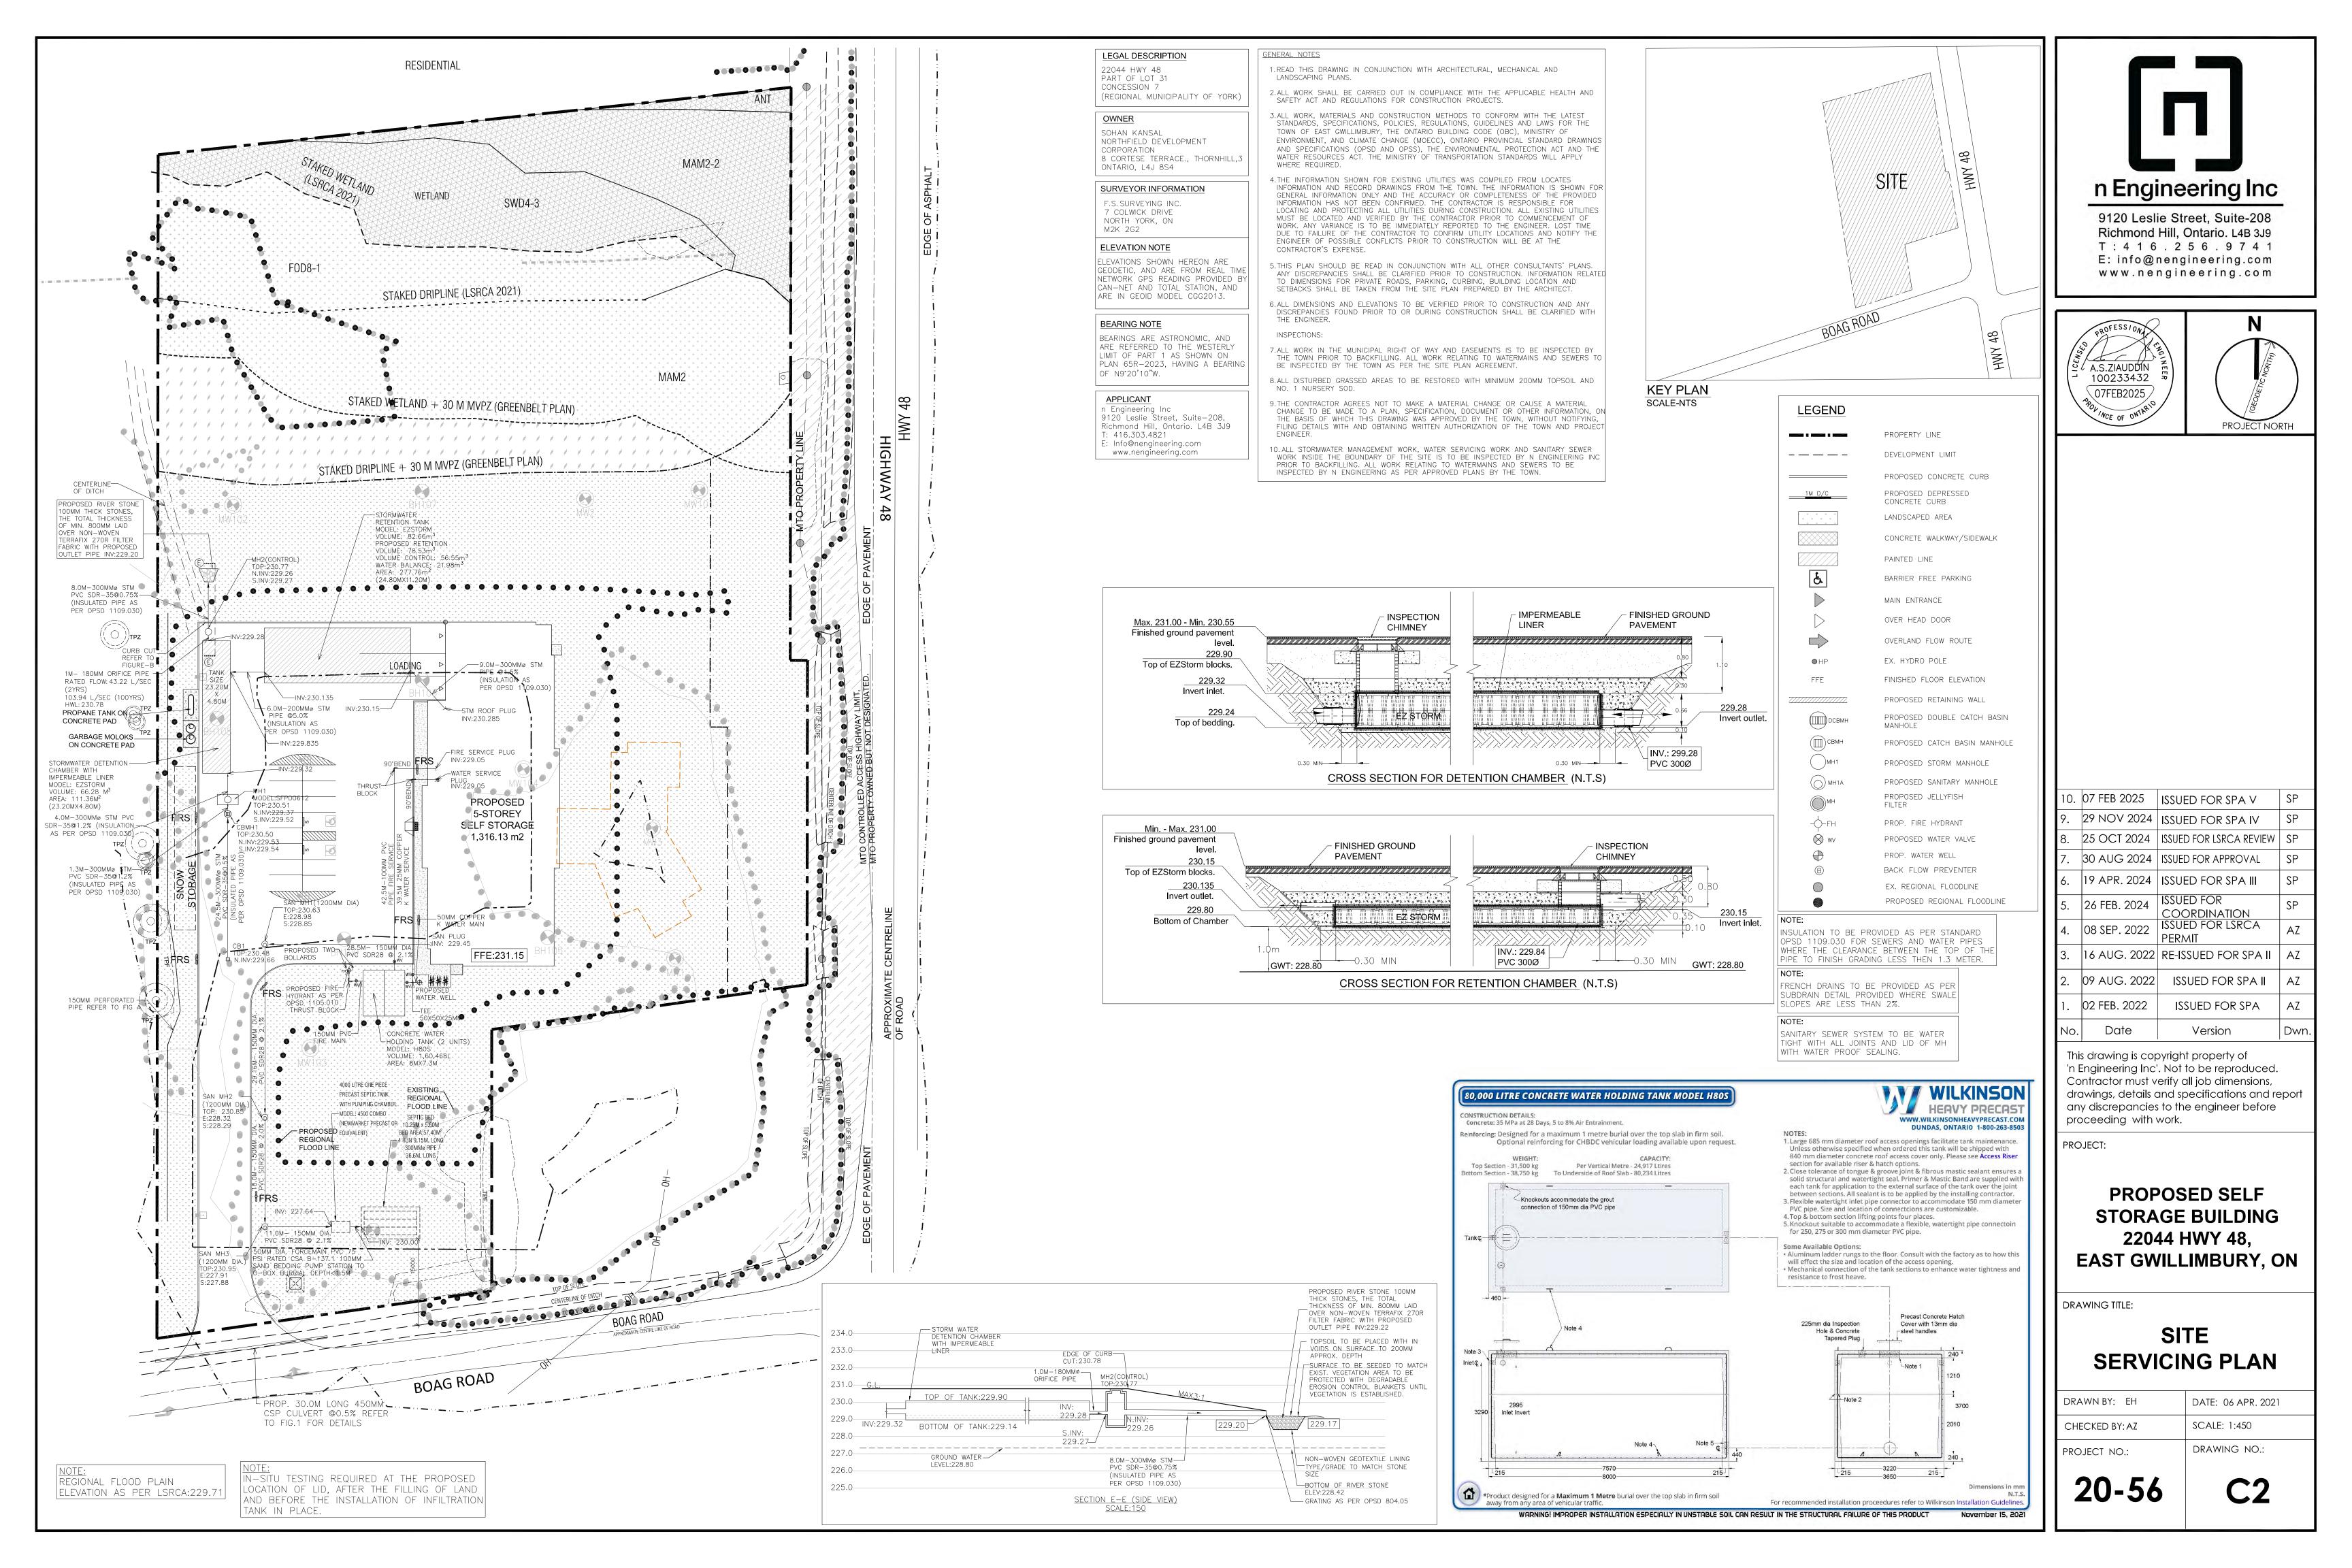



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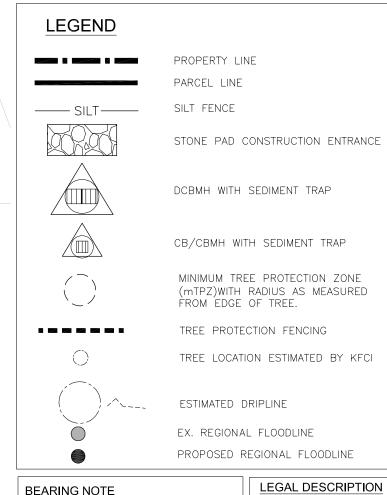
STORAGE BUILDING 22044 HWY 48, **EAST GWILLIMBURY, ON**

SITE GRADING

CHECKED BY: AZ	SCALE: 1:450
PROJECT NO.:	DRAWING NO.:





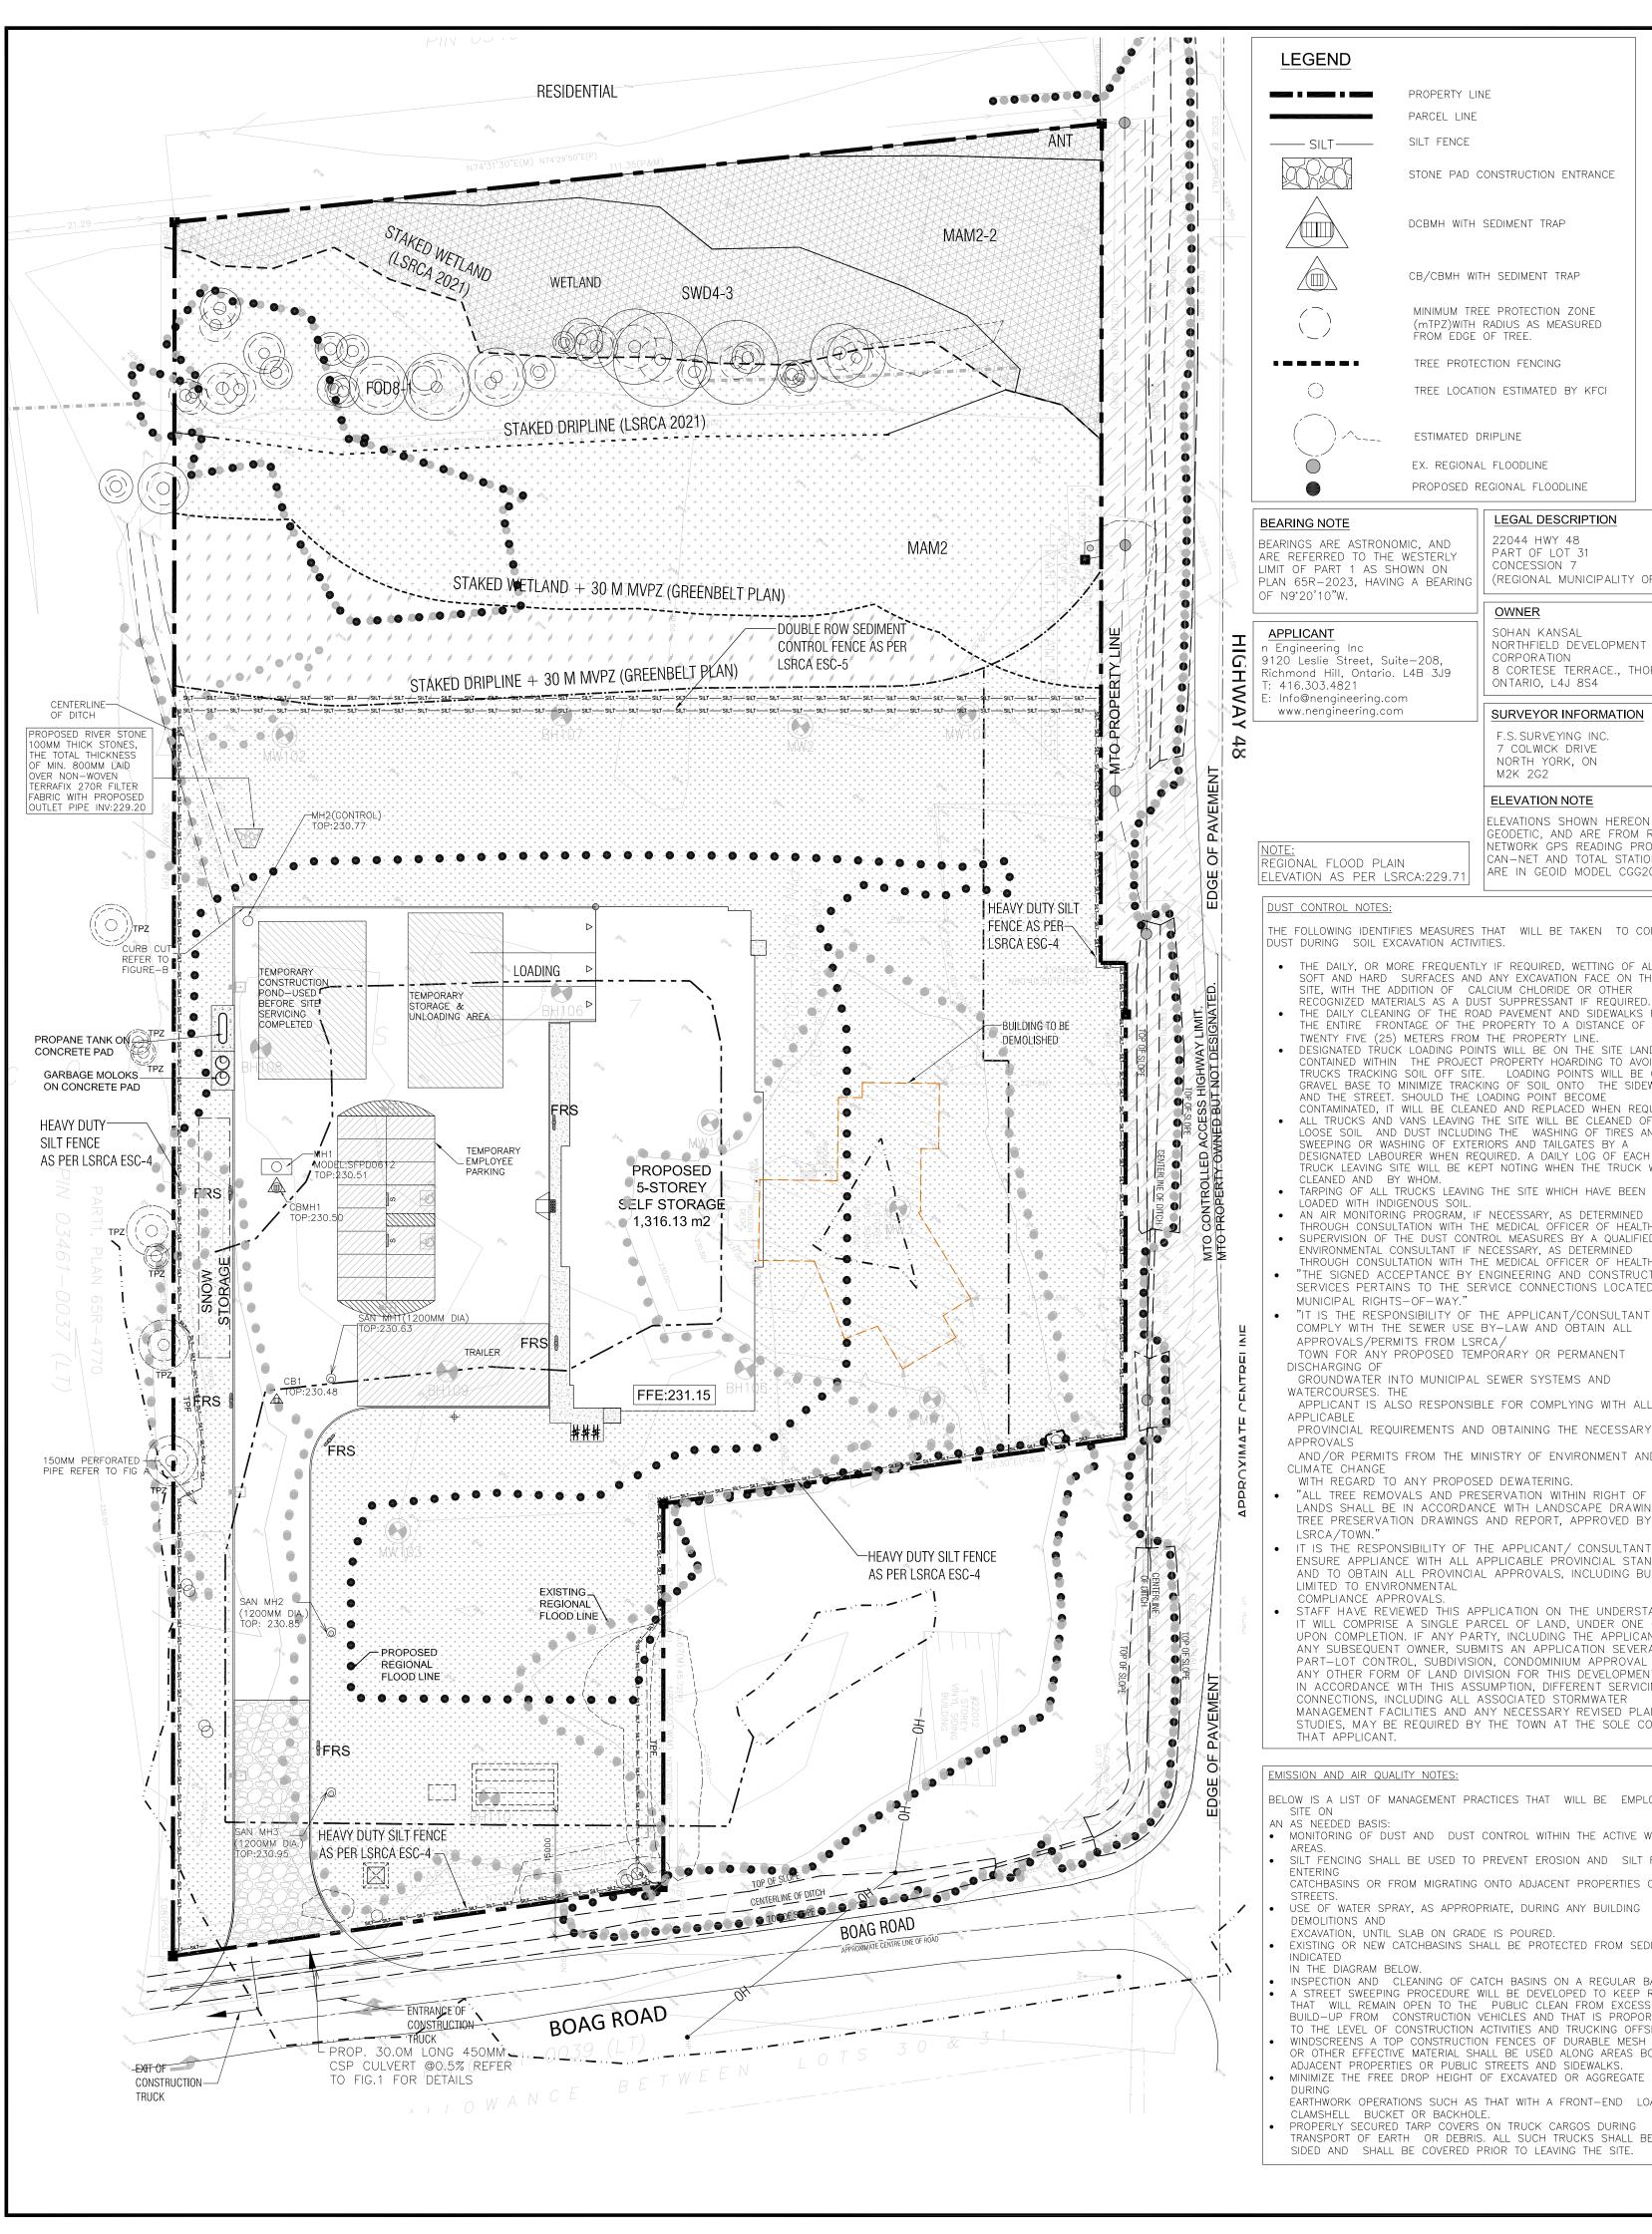

BEARINGS ARE ASTRONOMIC, AND ARE REFERRED TO THE WESTERLY LIMIT OF PART 1 AS SHOWN ON | PLAN 65R-2023, HAVING A BEARING | | (REGIONAL MUNICIPALITY OF YORK)

20 Leslie Street, Suite-208 ichmond Hill, Ontario. L4B 3J9

SURVEYOR INFORMATION F.S. SURVEYING INC. 7 COLWICK DRIVE NORTH YORK, ON M2K 2G2

ELEVATION NOTE

22044 HWY 48

PART OF LOT 31

CONCESSION 7

SOHAN KANSAL

CORPORATION

ONTARIO, L4J 8S4

NORTHFIELD DEVELOPMENT

8 CORTESE TERRACE., THORNHILL,3

OWNER


ELEVATIONS SHOWN HEREON ARE GEODETIC, AND ARE FROM REAL TIME NETWORK GPS READING PROVIDED E CAN-NET AND TOTAL STATION, AND ARE IN GEOID MODEL CGG2013.

THE FOLLOWING IDENTIFIES MEASURES THAT WILL BE TAKEN TO CONTROL DUST DURING SOIL EXCAVATION ACTIVITIES.

- THE DAILY, OR MORE FREQUENTLY IF REQUIRED, WETTING OF ALL SOFT AND HARD SURFACES AND ANY EXCAVATION FACE ON THE SITE, WITH THE ADDITION OF CALCIUM CHLORIDE OR OTHER
- THE DAILY CLEANING OF THE ROAD PAVEMENT AND SIDEWALKS FOR THE ENTIRE FRONTAGE OF THE PROPERTY TO A DISTANCE OF TWENTY FIVE (25) METERS FROM THE PROPERTY LINE DESIGNATED TRUCK LOADING POINTS WILL BE ON THE SITE LANDS
- CONTAINED WITHIN THE PROJECT PROPERTY HOARDING TO AVOID TRUCKS TRACKING SOIL OFF SITE. LOADING POINTS WILL BE ON A GRAVEL BASE TO MINIMIZE TRACKING OF SOIL ONTO THE SIDEWALK AND THE STREET. SHOULD THE LOADING POINT BECOME CONTAMINATED, IT WILL BE CLEANED AND REPLACED WHEN REQUIRED. ALL TRUCKS AND VANS LEAVING THE SITE WILL BE CLEANED OF ALL
- LOOSE SOIL AND DUST INCLUDING THE WASHING OF TIRES AND SWEEPING OR WASHING OF EXTERIORS AND TAILGATES BY A DESIGNATED LABOURER WHEN REQUIRED. A DAILY LOG OF FACH
- TARPING OF ALL TRUCKS LEAVING THE SITE WHICH HAVE BEEN LOADED WITH INDIGENOUS SOIL AN AIR MONITORING PROGRAM, IF NECESSARY, AS DETERMINED.
- THROUGH CONSULTATION WITH THE MEDICAL OFFICER OF HEALTH. SUPERVISION OF THE DUST CONTROL MEASURES BY A QUALIFIED.
- THROUGH CONSULTATION WITH THE MEDICAL OFFICER OF HEALTH "THE SIGNED ACCEPTANCE BY ENGINEERING AND CONSTRUCTION SERVICES PERTAINS TO THE SERVICE CONNECTIONS LOCATED WITHIN MUNICIPAL RIGHTS-OF-WAY." • "IT IS THE RESPONSIBILITY OF THE APPLICANT/CONSULTANT TO
- COMPLY WITH THE SEWER USE BY-LAW AND OBTAIN ALL APPROVALS/PERMITS FROM LSRCA/ TOWN FOR ANY PROPOSED TEMPORARY OR PERMANENT
- WATERCOURSES. THE APPLICANT IS ALSO RESPONSIBLE FOR COMPLYING WITH ALL THE PROVINCIAL REQUIREMENTS AND OBTAINING THE NECESSARY
- AND/OR PERMITS FROM THE MINISTRY OF ENVIRONMENT AND
- "ALL TREE REMOVALS AND PRESERVATION WITHIN RIGHT OF WAY LANDS SHALL BE IN ACCORDANCE WITH LANDSCAPE DRAWINGS AND TREE PRESERVATION DRAWINGS AND REPORT, APPROVED BY
- IT IS THE RESPONSIBILITY OF THE APPLICANT/ CONSULTANT TO ENSURE APPLIANCE WITH ALL APPLICABLE PROVINCIAL STANDARDS AND TO OBTAIN ALL PROVINCIAL APPROVALS, INCLUDING BUT NOT LIMITED TO ENVIRONMENTAL COMPLIANCE APPROVALS.
- STAFF HAVE REVIEWED THIS APPLICATION ON THE UNDERSTANDING IT WILL COMPRISE A SINGLE PARCEL OF LAND, UNDER ONE OWNER, UPON COMPLETION. IF ANY PARTY, INCLUDING THE APPLICANT OR ANY SUBSEQUENT OWNER, SUBMITS AN APPLICATION SEVERANCE, PART-LOT CONTROL. SUBDIVISION. CONDOMINIUM APPROVAL OR ANY OTHER FORM OF LAND DIVISION FOR THIS DEVELOPMENT NOT IN ACCORDANCE WITH THIS ASSUMPTION, DIFFERENT SERVICING CONNECTIONS, INCLUDING ALL ASSOCIATED STORMWATER MANAGEMENT FACILITIES AND ANY NECESSARY REVISED PLANS AND STUDIES, MAY BE REQUIRED BY THE TOWN AT THE SOLE COST TO

EMISSION AND AIR QUALITY NOTES:


- BELOW IS A LIST OF MANAGEMENT PRACTICES THAT WILL BE EMPLOYED ON
- MONITORING OF DUST AND DUST CONTROL WITHIN THE ACTIVE WORK SILT FENCING SHALL BE USED TO PREVENT EROSION AND SILT FROM CATCHBASINS OR FROM MIGRATING ONTO ADJACENT PROPERTIES OR
- EXCAVATION, UNTIL SLAB ON GRADE IS POURED. EXISTING OR NEW CATCHBASINS SHALL BE PROTECTED FROM SEDIMENT AS
- IN THE DIAGRAM BELOW. INSPECTION AND CLEANING OF CATCH BASINS ON A REGULAR BASIS. A STREET SWEEPING PROCEDURE WILL BE DEVELOPED TO KEEP ROADWAYS THAT WILL REMAIN OPEN TO THE PUBLIC CLEAN FROM EXCESSIVE DIRT BUILD-UP FROM CONSTRUCTION VEHICLES AND THAT IS PROPORTIONATE TO THE LEVEL OF CONSTRUCTION ACTIVITIES AND TRUCKING OFFSITE.
- WINDSCREENS A TOP CONSTRUCTION FENCES OF DURABLE MESH MATERIAL OR OTHER EFFECTIVE MATERIAL SHALL BE USED ALONG AREAS BORDERING ADJACENT PROPERTIES OR PUBLIC STREETS AND SIDEWALKS. MINIMIZE THE FREE DROP HEIGHT OF EXCAVATED OR AGGREGATE MATERIAL EARTHWORK OPERATIONS SUCH AS THAT WITH A FRONT-END LOADER CLAMSHELL BUCKET OR BACKHOLE.
- PROPERLY SECURED TARP COVERS ON TRUCK CARGOS DURING TRANSPORT OF EARTH OR DEBRIS. ALL SUCH TRUCKS SHALL BE FOUR

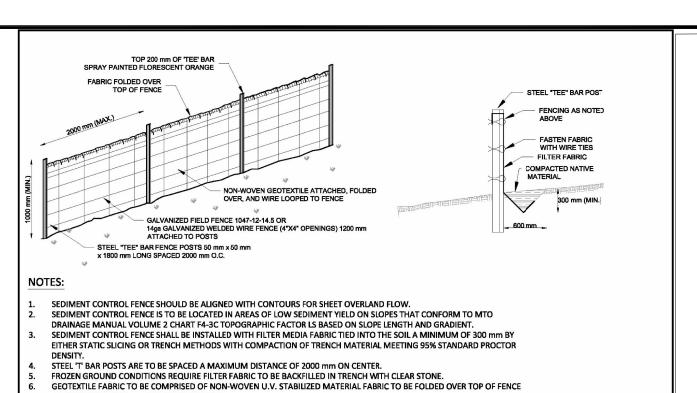

CONSTRUCTION OPERATIONS SHALL BE CARRIED OUT IN SUCH A MANNER THAT EROSION AND WATER POLLUTION IS

ALL DIMENSIONS IN MILLIMETRES UNLESS OTHERWISE SHOWN.

SWM GUIDELINES UPDATE 06.2016

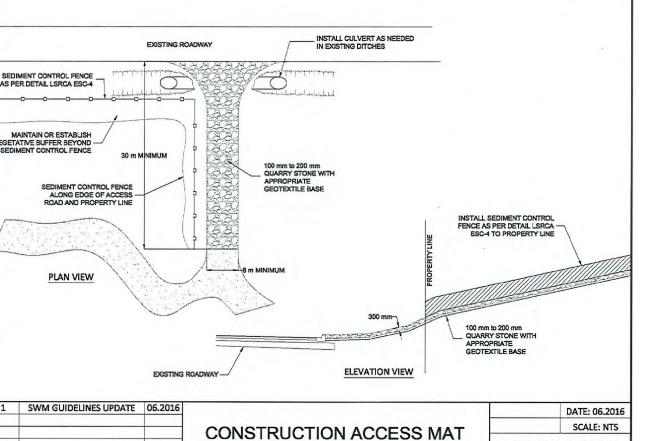

SEDIMENT CONTROL FENCE

- ALL SEDIMENT CONTROL MEASURES SUCH AS SEDIMENT CONTROL FENCE, TEMPORARY PONDS, CONSTRUCTION ACCESS MATS, SEDIMENT TRAPS, SWALES AND CHECK DAN MUST BE INSTALLED PRIOR TO THE COMMENCEMENT OF SITE WORKS.
 SEDIMENT CONTROLS SHOULD BE INSPECTED ON A REGULAR BASIS AND AFTER EVERY SIGNIFICANT RAINFALL EVENT. REPAIRS TO ESC MEASURES MUST BE COMPLETED IN A
 TIMELY MANNER TO PREVENT SEDIMENT MIGRATION.
 ADDITIONAL MATERIALS SUCH AS CLEAR STONE, FILTER FABRIC, PUMPS, HOSES AND SILTSOXX TO BE KEPT ONSITE AT ALL TIMES FOR CONDUCTING REPAIRS TO SEDIMENT CONTROL MEASURES.
 ALL DISTURBED AREAS LEFT INACTIVE FOR MORE THAN THIRTY DAYS ARE TO BE STABILIZED.
- ALL DISTURBED AREAS LEFT INACTIVE FOR MORE THAN THIRTY DAYS ARE TO BE STABILIZED.

 THE STABILIZATION SEED MIXTURE IS TO BE AS SPECIHED ON THE EROSION AND SEDIMENT CONTROL PLAN.

 THE STABILIZATION SEED MIXTURE IS TO BE AS SPECIHED ON THE EROSION AND SEDIMENT CONTROL PLAN.

 THE STABILIZATION SEED MIXTURE IS TO BE APPLIED AT A MINIMUM RATE OF 25 kg/ha.

 ENGINEERED CHANGES TO THE ESC MEASURES MAY BE NEEDED AS SITE CONDITIONS CHANGE THROUGHOUT THE CONSTRUCTION PROCESS. THESE UPDATES MUST REFLECT BEST

 MANAGEMENT PRACTICES TO CONTROL SEDIMENT AND EROSION ONSITE AND SHOULD BE COMPLETED BASED ON DIRECTION FROM THE SITE ENGINEER. ADDITIONAL MEASURES

 MAY BE REQUIRED AS DIRECTED BY AN ENGINEER THROUGHOUT THE CONSTRUCTION PROCESS.

 THE CONSTRUCTION ENTRANCE MAT IS TO BE INSTALLED AS THE FIRST STEP IN THE SITE ALTERATION PROCESS. SEDIMENT CONTROL FENCE IS TO BE INSTALLED DOWNSLOPE OF ALL DISTURBED AREAS. A DOUBLE ROW OF SEDIMENT CONTROL FENCE IS TO BE INSTALLED SURROUNDING
- NATURAL HERITAGE FEATURES AND AS DIRECTED BYTHE SITE ENGINEER. SEDIMENT CONTROL FENCE IS TO BE AS PER LSRCA STANDARD ESC-4 or ESC-5 AS A MINIMUM. LIGHT CUT-OFF SWALES OR DITCHES ARE TO BE INSTALLED AS SHOWN ON THE ESC PLANS AND AS NECESSARY BASED ON CHANGING SITE CONDITIONS TO DIRECT OVERLAND FLOW TO THE APPROPRIATE SEDIMENT TRAP OR TEMPORARY SEDIMENT POND. CHECK DAMS ARE TO BE INSTALLED IN ALL SWALES AND DITCHES IN ACCORDANCE WITH DRAWING LSRCA ESC-2. AS A MINIMUM EMPORARY SEDIMENT TRAP(S) ARE TO BE CONSTRUCTED AT THE BEGINNING OF SITE GRADING AND IF THE SITE DRAINAGE CHANGES DURING CONSTRUCTION. IT MAY BE
- NECESSARY FOR TEMPORARY SWALES TO BE CONSTRUCTED TO DIRECT SITE FLOWS TO THE TEMPORARY SEDIMENT TRAP(S) DURING ROUGH GRADING AND AS CONSTRUCTION TEMPORARY SEDIMENT POND(S) ARE TO BE CONSTRUCTED AT THE BEGINNING OF SITE GRADING AND IF THE SITE DRAINAGE CHANGES DURING CONSTRUCTION. IT MAY B
 NECESSARY FOR TEMPORARY SWALES TO BE CONSTRUCTED TO DIRECT SITE FLOWS TO THE TEMPORARY SEDIMENT POND(S) DURING ROUGH GRADING AND AS CONSTRUCTION FILTREX SILTSOXX OR APPROVED EQUIVALENT TO BE INSTALLED DOWNSTREAM FROM SEDIMENT TRAP AND TEMPORARY SEDIMENT POND OUTLETS TO A MINIMUM HEIGHT I
- 300mm.

 If STOCKPILES ARE USED ON-SITE FOR THE STORAGE OF EXCESS MATERIAL, THEY ARE TO BE IN ACCORDANCE WITH DETAIL DRAWING LSRCA ESC-6 OR BETTER. 15. IF SIGNATION AND SELECTION THE STORAGE OF EXCESSIONALERIAL, THEY ARE TO BE IN ACCORDANCE WITH DETAIL DRAWING LINCA ESC-6 OR BETTER.

 16. ANY DEWATERING OCCURRING ONSITE MUST BE IN ACCORDANCE WITH AN APPROVED DEWATERING PLAN. ADDITIONAL DEWATERING REQUIREMENTS MAY BE DEEMEL NECESSARY AND SHALL BE IMPLEMENTED AS DIRECTED BY THE ENGINEER, CONTRACT ADMINISTRATOR OR LOCAL MUNICIPALITY.

 17. THE SITE TRAILER IS TO BE LOCATED ONLY ATTHE DESIGNATED LOCATION HOWN ON THE PLANS.

 18. EQUIPMENT AND HYDROCARBON STORAGE IS TO OCCUR ONLY WITHIN THE DESIGNATED AREA SHOWN ON THE PLANS.

 19. REFUELING IS TO TAKE PLACE ONLY WITHIN THE DESIGNATED AREA SHOWN ON THE PLANS AND SHALL BE A MINIMUM OF THIRTY METRES FROM ANY WATERCOURSE OF ENVIRONMENTAL NUCLEUS TO THE PLANS.
- 9. REPUEING IS TO TAKE PLACE ONLY WITHIN THE DESIGNATED AREA SHOWN ON THE PLANS AND SHALL BE A MINIMUM OF THIRTY METRES FROM ANY WATERCOURSE OR ENVIRONMENTALLY SENSITIVE AREA.

 10. AN APPROVED SPILLS MANAGEMENT PLAN IS TO BE KEPT ONSITE.

 11. SPILL CLEANUP EQUIPMENT SUCH AS ABSORPTIVE MEDIA IS TO BE MAINTAINED ONSITE FOR IMMEDIATE USE IN THE EVENT OF A SPILL.

 12. SPILLS ARE TO BE REPORTED IMMEDIATELY TO THE MOECC SPILLS ACTION CENTRE AT 1-800-268-6060.

 13. THE CONTRACTOR WILL BE RESPONSIBLE FOR CLEANUP AND RESTORATION, INCLUDING ALL COSTS, DUE TO THE RELEASE OF SEDIMENT FROM THE SITE.

 14. LOW IMPACT DEVELOPMENT (LID) MEASURES ARE NOT TO BE USED AS SEDIMENT CONTROL DEVICES.

 15. ADDITIONAL SEDIMENT CONTROL DEVICES MAY BE DEEMED NECESSARY AND AS SITE CONDITIONS CHANGE AND SHALL BE INSTALLED AS DIRECTED BY THE SITE ENGINEER, CONTROL CONTROL DEVICED MAY BE DEEMED NECESSARY AND AS SITE CONDITIONS CHANGE AND SHALL BE INSTALLED AS DIRECTED BY THE SITE ENGINEER, CONTROL CONTROL DEVICED MAY BE DEEMED NECESSARY AND AS SITE CONDITIONS CHANGE AND SHALL BE INSTALLED AS DIRECTED BY THE SITE ENGINEER, CONTROL OF AND SHALL BE INSTALLED AS DIRECTED BY THE SITE ENGINEER, CONTROL OF AND SHALL BE INSTALLED AS DIRECTED BY THE SITE ENGINEER, CONTROL OF AND SHALL BE INSTALLED AS DIRECTED BY THE SITE ENGINEER, CONTROL OF ADMINISTRATOR OF LOCAL MUNICIPALITY.

CONTRACT ADMINISTRATOR OR LOCAL MUNICIPALITY SWM GUIDELINES UPDATE 06.2016



GRATE TO BE DOUBLE

CATCH BASIN FRAME

AND GRATE

WRAPED WITH GEOTEXTILE

WOVEN GEOTEXTILE TO HAVE A MINIMUM

EQUIVALENT OPENING SIZE OF 0.15MM

AND A MAXIMUM EQUIVALENT OPENING

SIZE OF 0.25MM OR A NON WOVEN

TO BE CONSIDERED BASED ON SOIL

PARAMETERS AND SITE CONDITIONS.

PERIODICALLY WHEN ACCUMULATED

SEDIMENTS INTERFERES WITH DRAINAGE

GEOTEXTILE TO BE REPLACED

TRANSPORTATION AND WORKS

OR AS DIRECTED BY THE


DEPARTMENT.

CATCH BASIN & CATCH BASIN MANHOLE

SEDIMENT CONTROL DEVICE

SCALE - N.T.S

SCALE: NTS LSRCA ESC-1

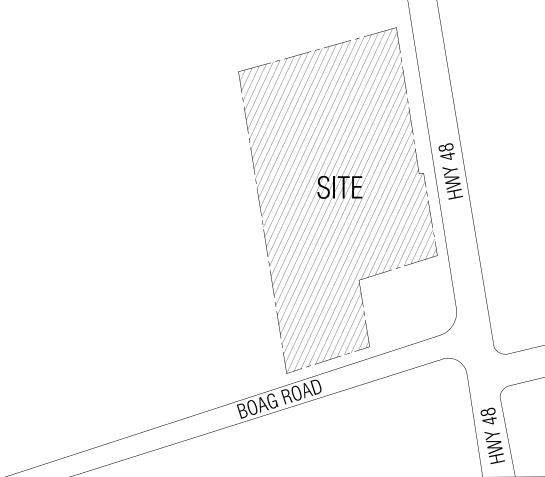

DATE: 06.2016

SCALE: NTS

LSRCA ESC-4

LSRCA ESC-3

GENERAL NOTES

1. READ THIS DRAWING IN CONJUNCTION WITH ARCHITECTURAL, MECHANICAL AND LANDSCAPING PLANS.

2.ALL WORK SHALL BE CARRIED OUT IN COMPLIANCE WITH THE APPLICABLE HEALTH AND SAFETY ACT AND REGULATIONS FOR CONSTRUCTION PROJECTS.

3.ALL WORK, MATERIALS AND CONSTRUCTION METHODS TO CONFORM WITH THE LATEST STANDARDS, SPECIFICATIONS, POLICIES, REGULATIONS, GUIDELINES AND LAWS FOR THE TOWN OF EAST GWILLIMBURY, THE ONTARIO BUILDING CODE (OBC), MINISTRY OF ENVIRONMENT, AND CLIMATE CHANGE (MOECC), ONTARIO PROVINCIAL STANDARD DRAWINGS AND SPECIFICATIONS (OPSD AND OPSS), THE ENVIRONMENTAL PROTECTION ACT AND THE WATER RESOURCES ACT. THE MINISTRY OF TRANSPORTATION STANDARDS WILL APPLY

4.THE INFORMATION SHOWN FOR EXISTING UTILITIES WAS COMPILED FROM LOCATES INFORMATION AND RECORD DRAWINGS FROM THE TOWN. THE INFORMATION IS SHOWN FOR GENERAL INFORMATION ONLY AND THE ACCURACY OR COMPLETENESS OF THE PROVIDED INFORMATION HAS NOT BEEN CONFIRMED. THE CONTRACTOR IS RESPONSIBLE FOR LOCATING AND PROTECTING ALL UTILITIES DURING CONSTRUCTION. ALL EXISTING UTILITIES MUST BE LOCATED AND VERIFIED BY THE CONTRACTOR PRIOR TO COMMENCEMENT OF WORK. ANY VARIANCE IS TO BE IMMEDIATELY REPORTED TO THE ENGINEER. LOST TIME DUE TO FAILURE OF THE CONTRACTOR TO CONFIRM UTILITY LOCATIONS AND NOTIFY THE ENGINEER OF POSSIBLE CONFLICTS PRIOR TO CONSTRUCTION WILL BE AT THE CONTRACTOR'S EXPENSE.

5.THIS PLAN SHOULD BE READ IN CONJUNCTION WITH ALL OTHER CONSULTANTS' PLANS. ANY DISCREPANCIES SHALL BE CLARIFIED PRIOR TO CONSTRUCTION. INFORMATION RELATED TO DIMENSIONS FOR PRIVATE ROADS, PARKING, CURBING, BUILDING LOCATION AND SETBACKS SHALL BE TAKEN FROM THE SITE PLAN PREPARED BY THE ARCHITECT.


6.ALL DIMENSIONS AND ELEVATIONS TO BE VERIFIED PRIOR TO CONSTRUCTION AND ANY DISCREPANCIES FOUND PRIOR TO OR DURING CONSTRUCTION SHALL BE CLARIFIED WITH THE ENGINEER.

7.ALL WORK IN THE MUNICIPAL RIGHT OF WAY AND EASEMENTS IS TO BE INSPECTED BY THE TOWN PRIOR TO BACKFILLING. ALL WORK RELATING TO WATERMAINS AND SEWERS TO BE INSPECTED BY THE TOWN AS PER THE SITE PLAN AGREEMENT.

8.ALL DISTURBED GRASSED AREAS TO BE RESTORED WITH MINIMUM 200MM TOPSOIL AND NO. 1 NURSERY SOD.

9.THE CONTRACTOR AGREES NOT TO MAKE A MATERIAL CHANGE OR CAUSE A MATERIAL CHANGE TO BE MADE TO A PLAN, SPECIFICATION, DOCUMENT OR OTHER INFORMATION, THE BASIS OF WHICH THIS DRAWING WAS APPROVED BY THE TOWN, WITHOUT NOTIFYING,

10.ALL STORMWATER MANAGEMENT WORK, WATER SERVICING WORK AND SANITARY SEWER WORK INSIDE THE BOUNDARY OF THE SITE IS TO BE INSPECTED BY N ENGINEERING IN PRIOR TO BACKFILLING. ALL WORK RELATING TO WATERMAINS AND SEWERS TO BE INSPECTED BY N ENGINEERING AS PER APPROVED PLANS BY THE TOWN.

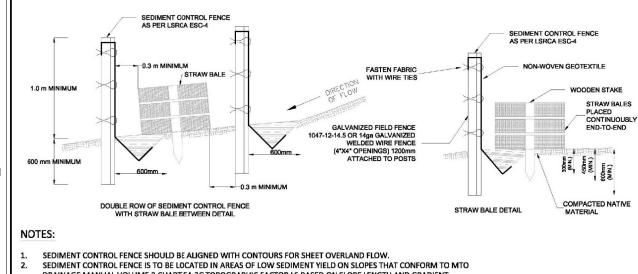

DRAINAGE MANUAL VOLUME 2 CHART F4-3C TOPOGRAPHIC FACTOR LS BASED ON SLOPE LENGTH AND GRADIENT.
SEDIMENT CONTROL FENCE SHALL BE INSTALLED WITH FILTER MEDIA FABRIC TIED INTO THE SOIL A MINIMUM OF 300 mm BY EITHER STATIC SLICING OR TRENCH METHODS WITH COMPACTION OF TRENCH MATERIAL MEETING 95% STANDARD PROCTOR MAXIMUM DRY DENSITY. STEEL 'T' BAR POSTS ARE TO BE SPACED A MAXIMUM DISTANCE OF 2000 mm ON CENTER.


STRAW BALES TO BE PLACED END-TO-END CONTINUOUSLY BETWEEN SEDIMENT CONTROL FENCES.
FROZEN GROUND CONDITIONS REQUIRE FILTER FABRIC TO BE BACKFILLED IN TRENCH WITH CLEAR STONE. GEOTEXTILE FABRIC TO BE COMPRISED OF NON-WOVEN U.V. STABILIZED MATERIAL FABRIC TO BE FOLDED OVER TOP OF FENCE A MINIMUM OF 300 mm AND WIRE FASTENED CONSTRUCTION OPERATIONS SHALL BE CARRIED OUT IN SUCH A MANNER THAT EROSION AND WATER POLLUTION IS


ALL DIMENSIONS IN MILLIMETRES UNLESS OTHERWISE SHOWN. SWM GUIDELINES UPDATE 06.2016

-			DOUBLE ROW	SCALE: NTS	ı
			SEDIMENT CONTROL FENCE	LSRCA ESC-5	ı
	REVISION	DATE		20110/1200	ı
					ı

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9120 Leslie Street, Suite-208 Richmond Hill, Ontario. L4B 3J9 T: 416.256.9741 E: info@nengineering.com www.nengineering.com



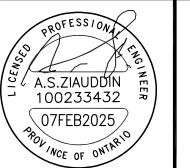

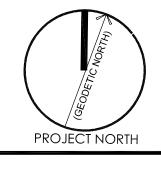10.	07 FEB 2025	ISSUED FOR SPA V	SP
9.	29 NOV 2024	ISSUED FOR SPA IV	SP
8.	25 OCT 2024	ISSUED FOR LSRCA REVIEW	SP
7.	30 AUG 2024	ISSUED FOR APPROVAL	SP
6.	19 APR. 2024	ISSUED FOR SPA III	SP
5.	26 FEB. 2024	ISSUED FOR COORDINATION	SP
4.	08 SEP. 2022	ISSUED FOR LSRCA PERMIT	ΑZ
3.	16 AUG. 2022	RE-ISSUED FOR SPA II	ΑZ
2.	09 AUG. 2022	ISSUED FOR SPA II	ΑZ
1.	02 FEB. 2022	issued for spa	ΑZ
No.	Date	Version	Dwn.

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PROJECT:

PROPOSED SELF **STORAGE BUILDING** 22044 HWY 48, **EAST GWILLIMBURY, ON**

DRAWING TITLE:

DRAWN BY: EH

DATE: 06.2016

CONSTRUCTION **MANAGEMENT AND EROSION & SEDIMENT CONTROL PLAN**

CHECKED BY: AZ	SCALE: 1:450
PROJECT NO.:	DRAWING NO.:

20-56

DATE: 06 APR. 2021

NOTE FOR TIMING OF VEGETATION REMOVAL

IT IS RECOMMENDED THAT DURING THE PEAK PERIOD OF BIRD NESTING (i.e. BETWEEN MID-APRIL AND MID-JULY). NO VEGETATION CLEARING OR DISTURBANCE TO NESTING BIRD HABITAT SHOULD OCCUR. IF NESTING IS FOUND, THEN VEGETATION CLEARING IN AN AREA AROUND THE NEST, THE SIZE OF WHICH

DEPENDS ON THE SPECIFIC CIRCUMSTANCES, HAS TO WAIT UNTIL NESTING HAS CONCLUDED. FROM SEPTEMBER 1 THROUGH MARCH 31, VEGETATION CLEARING CAN OCCUR WITHOUT NEST SURVEYS, BUT THE NEED TO ENSURE NEST PROTECTION STILL APPLIES (i.e. IF AN ACTIVE NEST IS KNOWN TO BE

THE DEVELOPMENT WILL COMPRISE A SINGLE PARCEL OF LAND, UNDER ONE

OWNER, UPON COMPLETION, IF ANY PARTY, INCLUDING THE APPLICANT OR ANY

SUBSEQUENT OWNER, SUBMITS AN APPLICATION FOR SEVERANCE, PART-LOT


CONTROL, SUBDIVISION, CONDOMINIUM APPROVAL OR ANY OTHER FORM OF LAND DIVISION FOR THIS DEVELOPMENT NOT IN ACCORDANCE WITH THIS ASSUMPTION,

DIFFERENT SERVICING CONNECTIONS, INCLUDING ALL ASSOCIATED STORMWATER

MANAGEMENT FACILITIES AND ANY NECESSARY REVISED PLANS AND STUDIES, MAY

BE REQUIRED BY THE TOWN AT THE SOLE COST TO THE APPLICANT.

FOR ANY REMOVALS WITHIN WOODED AREAS THAT HAVE THE POTENTIAL TO PROVIDE HABITAT, REMOVALS MUST OCCUR BETWEEN OCTOBER 1 AND MARCH 31 IN ACCORDANCE WITH MECP REQUIREMENTS.

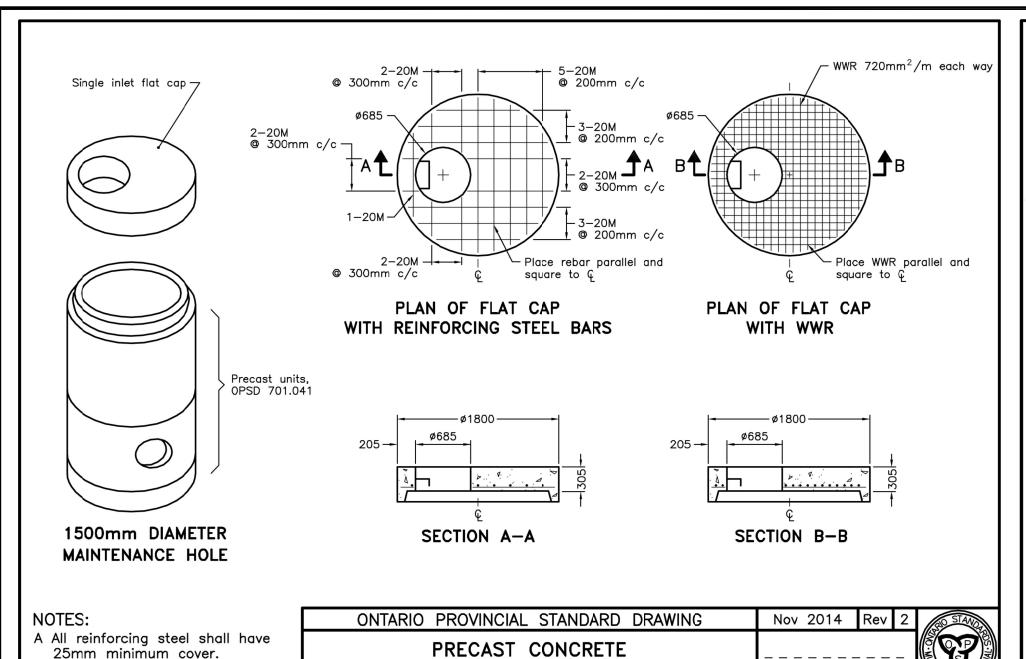

SINGLE INLET FLAT CAP


1500mm DIAMETER


OPSD 703.011


B All dimensions are nominal.


unless otherwise shown.


C All dimensions are in millimetres

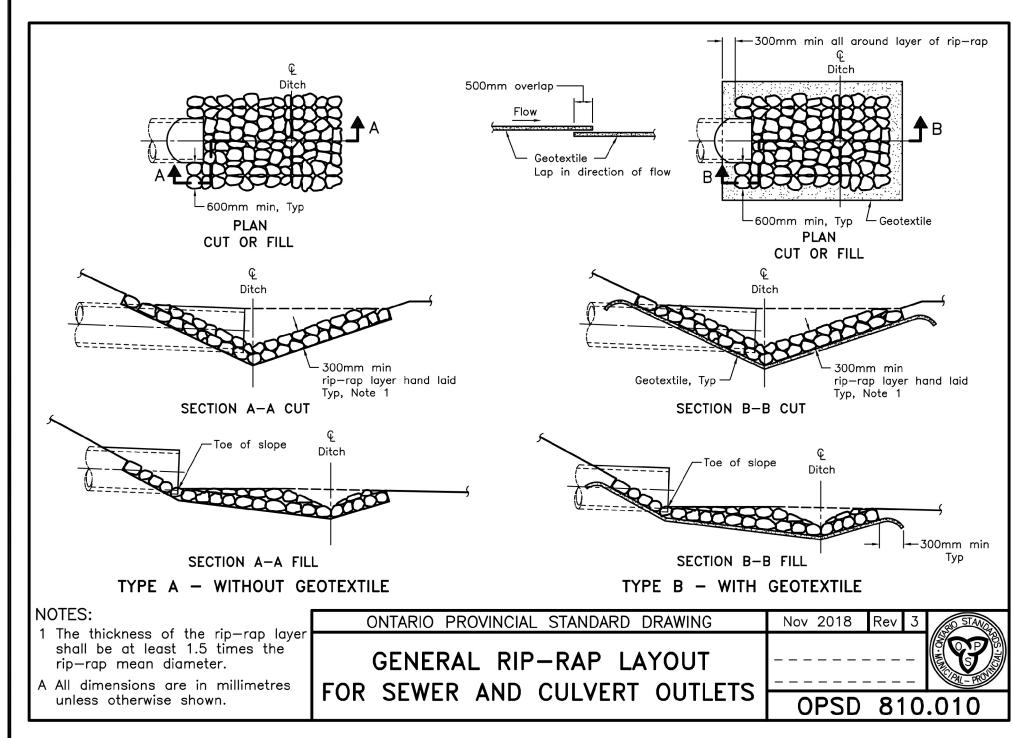


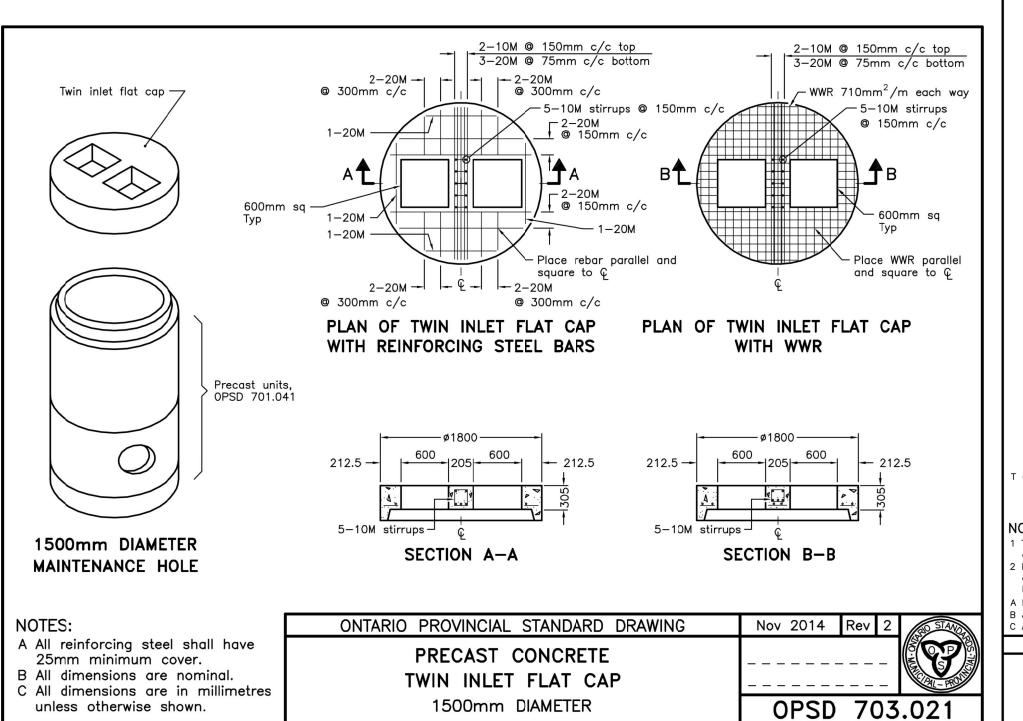


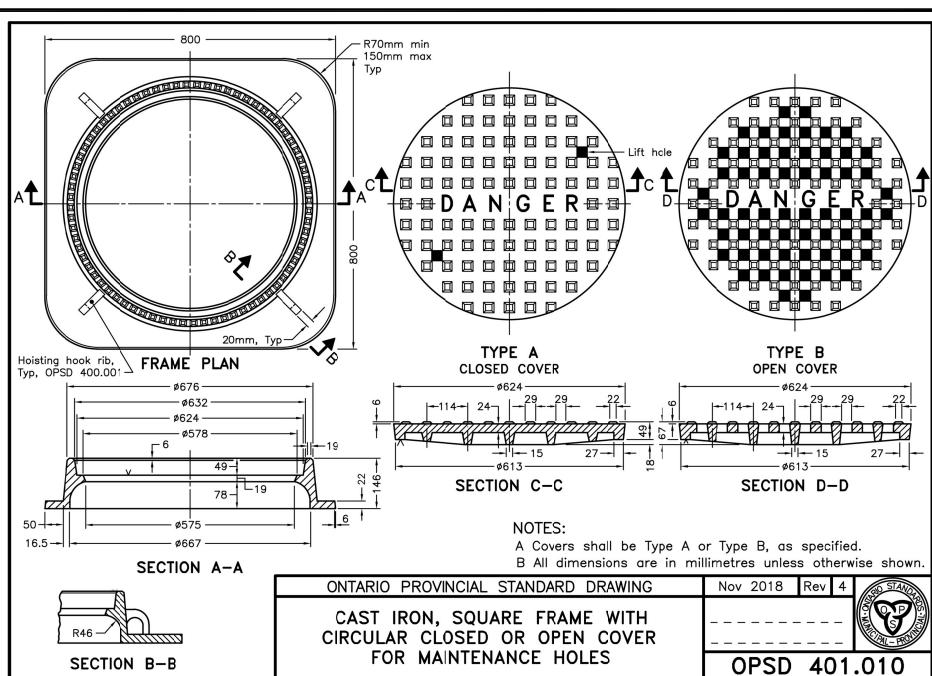

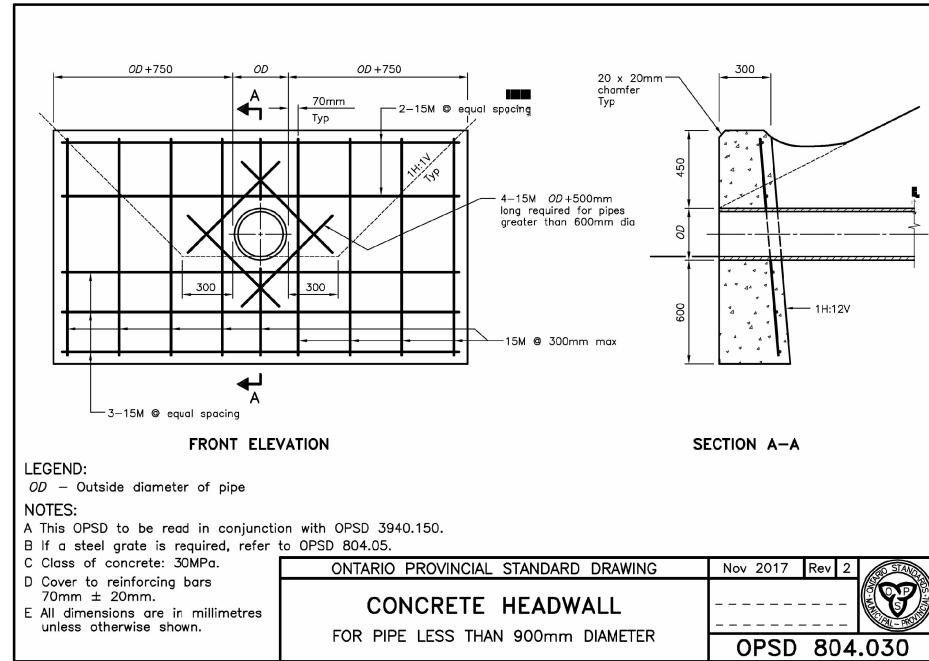

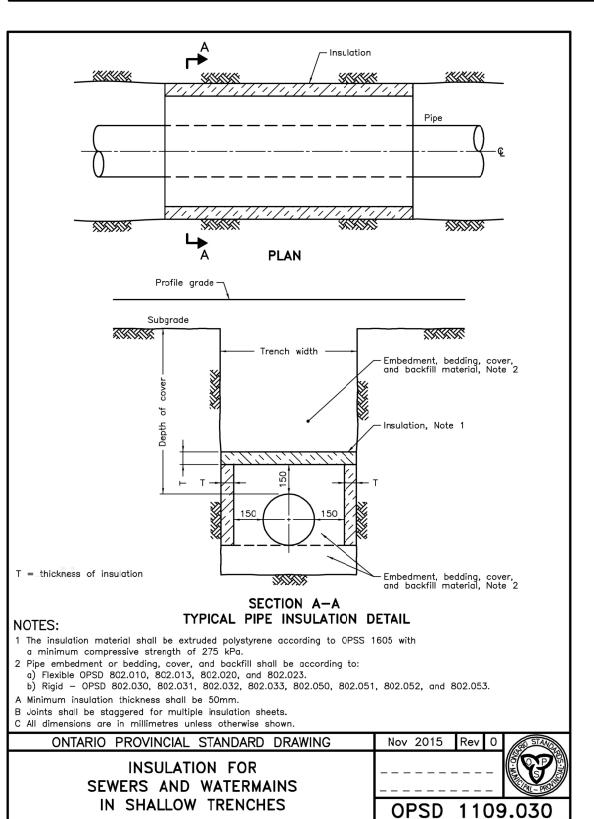

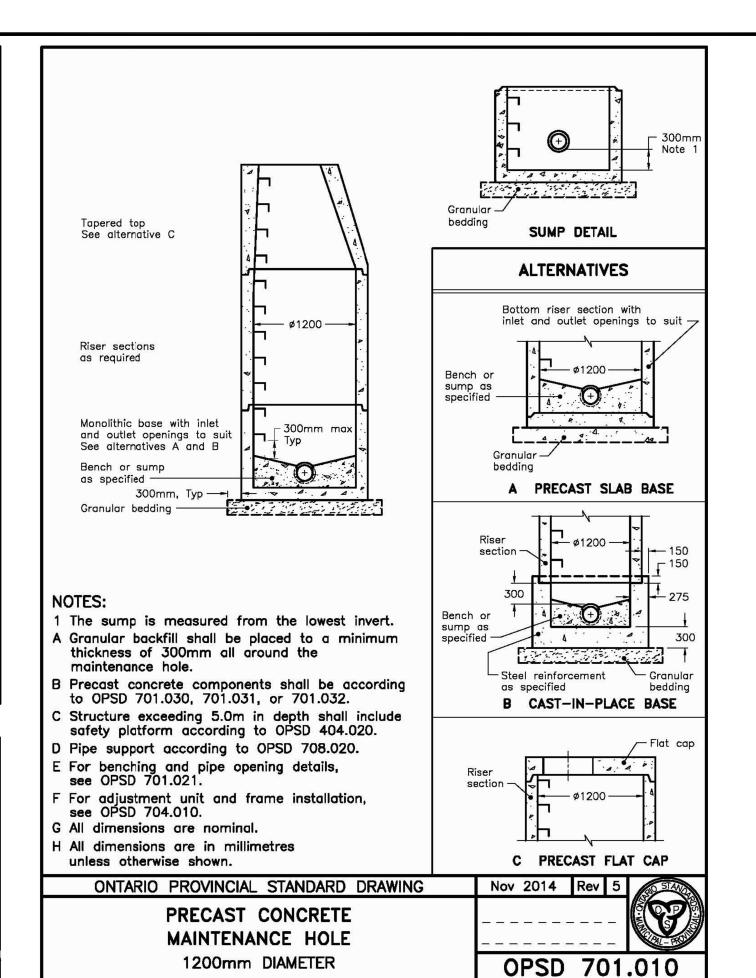

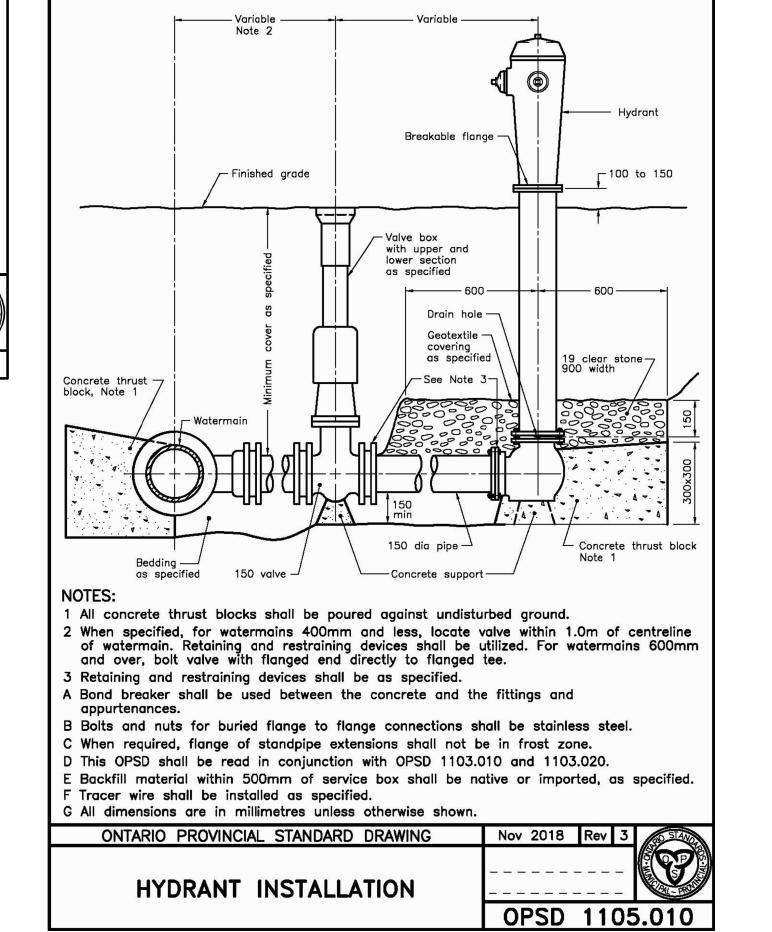




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PROPOSED SELF STORAGE BUILDING 22044 HWY 48, EAST GWILLIMBURY, ON

DRAWING TITLE:

DRAWN BY: EH

STANDARD DETAILS

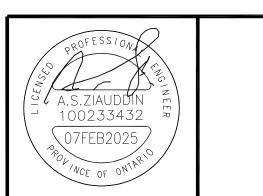CHECKED BY: AZ SCALE: 1:450

PROJECT NO.: DRAWING NO.:

20-56

C4

DATE: 06 APR. 2021